PLUMBING SYMBOLS & ABBREVIATIONS

NOTE: NOT ALL SYMBOLS ARE USED ON THIS PROJECT

ANNOTATION ABBREVIATIONS				PLUMBING S	YMBC	LOGY	ANNO	ANNOTATION SYMBOLOGY					
AC	ABOVE CEILING	E CEILING GPM GALLONS PER MINUTE			PIPING SYSTEM	—	VACUUM RELIEF VALVE	#)	PLUMBING KEYNOTE				
AFF	ABOVE FINISHED FLOOR	GC	GENERAL CONTRACTOR	—	CA COMPRESSED AIR		BACKFLOW PREVENTER		T EGIVIDING NETTICE				
BAS	BUILDING AUTOMATION SYSTEM	HAP	HIGH AS POSSIBLE		CD CONDENSATE DRAIN P PROPANE GAS	-01	HOSE BIBB / WALL HYDRANT		PLUMBING EQUIPMENT DESIGNATION				
BF	BELOW FLOOR	НВ	HOSE BIBB (INTERIOR)		OST OVERFLOW STORM	-1▶	AUTOMATIC AIR VENT		DETAIL MODULE NUMBER				
BG	BELOW GRADE	HS	HOSE STATION		OW OIL WASTE PD PUMP DISCHARGE	T	PRESSURE GAUGE	T (####	DETAIL OR SECTION MARK				
ВН	BOOSTER HEATER	HWCP	HOT WATER RECIRCULATION PUMP		ST STORM W SANITARY WASTE	1	THERMOMETER		SHOWN ON DRAWING				
BFP	BACKFLOW PREVENTION DEVICE	HWS	HANDWASHING SINK		OV OIL VENT	■ -F	FLOW SWITCH						
BJ	BETWEEN JOISTS	IM	ICE MAKER		V SANITARY VENT	■ -P	PRESSURE SWITCH	1					
ВОР	BOTTOM OF PIPE	L	LAVATORY	——	CW DOMESTIC COLD WATER	■ -(T)	TEMPERATURE SWITCH	1					
BTUH	BRITISH THERMAL UNITS PER HOUR	LT	LAUNDRY TUB		NPCW NONPOTABLE COLD WATER		PIPE UNION	1					
CF	COMBINATION FIXTURE	MBH	THOUSANDS OF BTU PER HOUR		HW DOMESTIC HOT WATER		WYE STRAINER	1					
COND	CONDENSATE	МС	MECHANICAL CONTRACTOR		HW 140 DOMESTIC HOT WATER (OTHER TEMP.)		WYE STRAINER W/DRAIN VALVE	1					
СР	CONDENSATE PUMP	MSB	MOP SINK BASIN		HWC DOMESTIC HW RECIRCULATION	, jack	WTE STRAINER W/DRAIN VALVE						
CSS	CLINICAL SERVICE SINK	NTS	NOT TO SCALE		PIPE SLOPE ARROW	•	PUMP	1					
CV	CONTROL VALVE	ORD	OVERFLOW ROOF DRAIN	-	FLOW ARROW	⊜or 🗏	FLOOR DRAIN - ROUND OR SQUARE	1					
DF	DRINKING FOUNTAIN	Р	PUMP	—	CONCENTRIC REDUCER	● OR	FLOOR CLEANOUT - ROUND OR SQUARE	1					
DN	DOWN	PC	PLUMBING CONTRACTOR		ECCENTRIC REDUCER	—п со	SUSPENDED CLEANOUT	1					
DW	DISHWASHER	PRV	PRESSURE RELIEF VALVE	—	3-WAY CONTROL VALVE	—II WCO	WALL CLEANOUT	1					
EC	ELECTRICAL CONTRACTOR	RD	ROOF DRAIN	—	ANGLE GATE VALVE		PIPE CAP	1					
EEW	EMERGENCY EYE WASH	RPZ	REDUCED PRESSURE BFP	<u></u>	ANGLE GLOBE VALVE		PIPE TURNING DOWN	1					
EEWSH	COMB. EMERGENCY EYE WASH/SHOWER	SE	SEWAGE EJECTOR		BALANCING/SHUTOFF VALVE	—	PIPE TURNING UP						
ES	EJECTOR SUMP	SF	SQUARE FOOT		BALL VALVE		TEE UP	1					
ET	EXPANSION TANK	SH	SHOWER	-1/1	BUTTERFLY VALVE	-\$-	TEE DOWN						
EWC	ELECTRIC WATER COOLER	SK	SINK	— Ы	CALIBRATED BALANCING VALVE	——	DROP AND RUN						
EWH	ELECTRIC WATER HEATER	SP	SUMP PUMP	- -	CHECK VALVE	-	DROP AND TURN	1					
FA	FROM ABOVE	SS	SERVICE SINK	1	CONTROL VALVE	- P-	TEE OFF TOP	1					
FB	FROM BELOW	TFA	TO FLOOR ABOVE		GAS COCK	- ŷ-	TEE OFF BOTTOM	1					
FBO	FURNISHED BY OTHERS	ТВ	TO BELOW	— ↓	GATE VALVE	-	CROSS AND RISER	1					
FCO	FLOOR CLEANOUT	TFB	TO FLOOR BELOW	_ _	GLOBE VALVE	7	PLAN 90° ELBOW	1					
FD	FLOOR DRAIN	TMV	THERMOSTATIC MIXING VALVE		PLUG VALVE	_t_	PIPE TEE	1					
FFA	FROM FLOOR ABOVE	TOP	TOP OF PIPE		PRESSURE REDUCING VALVE (WATER)		FLEXIBLE PIPE CONNECTOR	1					
FFB	FROM FLOOR BELOW	VB	VACUUM BREAKER		PRESSURE REGULATOR (GAS)	$\overline{}$	PIPE ANCHOR						
FPC	FIRE PROTECTION SUBCONTRACTOR	VTR	VENT THRU ROOF		QUICK OPEN VALVE		PIPE GUIDES	7					
FS	FLOOR SINK	WC	WATER CLOSET	J	SAFETY RELIEF VALVE	M	WATER METER	7					
GCO	YARD CLEANOUT	wco	WALL CLEANOUT		SOLENOID VALVE		•	7					



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ELEVEN MILE PHASE 1 BID SET
 PROJECT NO.:
 0180930.00

 DRAWN:
 SH

 REVIEWED:
 JB/CF

 DATE:
 09/12/18

PLUMBING GENERAL NOTES

- A. WORK SHALL BE PERFORMED BY A LICENSED PLUMBER OF THE STATE OF COLORADO.
- MATERIALS, INSTALLATION AND TESTING SHALL BE IN ACCORDANCE WITH THE LATEST ADOPTED EDITION OF
 - ANDLOCAL CODE PROCEDURES, METHODS AND REQUIREMENTS, INCLUDING THE MOST STRINGENT OF HEALTH AND
 - SAFETY STANDARDS AS REQUIRED AND AS INTERPRETED BY THE AUTHORITY HAVING JURISDICTION.
 - CODE AND STANDARDS REQUIRED, BUT NOT LIMITED TO THE FOLLOWING:
 - "COLORADO STATE PLUMBING CODE" (2017 EDITION)
 - "INTERNATIONAL PLUMBING CODE" (2015 EDITION)
 - "NFPA 54 NATIONAL FUEL GAS CODE"
 - APPLICABLE LOCAL AND MUNICIPAL CODES AND ORDINANCES.
- MEANING AND INTENT OF DRAWINGS: DRAWINGS ARE DIAGRAMMATIC. PIPING IS SHOWN IN SCHEMATIC FORM. SCALES INDICATED ARE FOR ARCHITECTURAL REFERENCE ONLY. IT IS NOT INTENDED THAT THE DRAWINGS SHOW EVERY WASTE, VENT, WATER PIPE, FITTING, SUPPORTS, ETC., AND IT IS UNDERSTOOD THAT THE DRAWINGS MUST BE FOLLOWED AS CLOSELY AS CIRCUMSTANCES WILL PERMIT, THE PROPER INSTALLATION ACCORDING TO THE TRUE INTENT AND MEANING OF THE DRAWINGS, LOCAL CODES AND STANDARD PRACTICES SHALL BE PROVIDED. PLUMBING CONTRACTOR SHALL FIELD VERIFY ALL EXISTING CONDITIONS PRIOR TO INSTALLATION. REPORT ANY PROBLEMS OR CONFLICTS TO THE ARCHITECT/ENGINEER. NOTED DIMENSIONS TAKE PRECEDENCE OVER SCALED DIMENSIONS. DO NOT SCALE DRAWINGS. ANY MINOR CHANGES IN LOCATION OF EQUIPMENT, WASTE VENT, WATER PIPE, ETC.. FROM THOSE LOCATIONS SHOWN ON THE DRAWINGS. SHALL BE MADE WITHOUT EXTRA COST. IF SO DIRECTED BY THE ARCHITECT/ENGINEER BEFORE THE INSTALLATION IS MADE. A MINOR CHANGE IN LOCATION IS CONSIDERED TO BE WITHIN 5'-0" OF THE ORIGINAL INDICATED LOCATION. THE EQUIPMENT INDICATED ON THESE DRAWINGS INCLUDE ONLY THE MAJOR EQUIPMENT REQUIREMENTS. NOT WITHSTANDING, THE DETAILS PRESENTED IN THESE DRAWINGS VERIFY THE COMPLETENESS OF THE MATERIALS LISTS AND SUITABILITY OF DEVICES TO MEET THE INTENT OF THIS PROJECT. ANY ADDITIONAL EQUIPMENT OR MATERIAL REQUIRED, EVEN IF NOT SPECIFICALLY MENTIONED HEREIN SHALL BE PROVIDED WITHOUT CLAIM FOR ADDITIONAL PAYMENT; IT BEING UNDERSTOOD THAT A COMPLETE AND OPERATIONAL PLUMBING SYSTEM, SATISFACTORY TO THE ARCHITECT/ENGINEER AND THE OWNER SHALL BE PROVIDED. USE ONLY THE MANUFACTURER'S TESTED ASSEMBLIES.
- D. ALL GENERAL NOTES ARE PART OF THIS CONTRACT.
- ALL EXPENSES CARRIED BY THE ARCHITECT/ENGINEER IN TROUBLESHOOTING SYSTEM(S) PROBLEMS CAUSED BY INADEQUATE WORKMANSHIP, LACK OF TECHNICAL EXPERTISE OR OTHER FORMS OF POOR PERFORMANCE ON THE PART OF A CONTRACTOR, SHALL BE BORN BY THAT CONTRACTOR.
- PLUMBING CONTRACTOR IS RESPONSIBLE FOR ALL SERVICES IN BUILDING AND TO 5'-0" BEYOND THE BUILDING CONSTRUCTION LINE. SITE UTILITY CONTRACTOR IS RESPONSIBLE FOR ALL OTHER PIPING.
- COORDINATE ROUTING OF PIPING WITH ALL OTHER TRADES AND STRUCTURAL CONDITIONS TO AVOID ANY CONFLICTS AND ADVISE ARCHITECT/ENGINEER OF ANY POSSIBLE CONFLICTS. VERIFY EXACT LOCATIONS, ELEVATIONS, AND DIMENSIONS OF STRUCTURAL MEMBERS AND OPENINGS.
- MAINTAIN A MINIMUM CLEARANCE OF 3'-0" IN FRONT OF ELECTRICAL PANELS AND 1'-0" EITHER SIDE FROM STRUCTURE TO STRUCTURE AND FLOOR TO STRUCTURE. ROUTE PIPING AROUND AND NOT DIRECTLY ABOVE ELECTRICAL PANELS. VERIFY CLEARANCE REQUIREMENTS WITH ELECTRICAL CONTRACTOR PRIOR TO INSTALLING PIPE.
- INCLUDE IN BID, ALL LICENSE, PERMIT, INSPECTION AND OTHER FEES REQUIRED BY UTILITY COMPANIES OR AUTHORITIES HAVING JURISDICTION REQUIRED FOR COMPLETION OF WORK SO THAT NO UNEXPECTED ADDITIONAL EXPENSES ARE INTRODUCED TO OWNER.

- PROMPTLY INFORM THE ENGINEER, IN WRITING, OF ANY DEVIATIONS IN THE CONTRACT DOCUMENTS FROM REQUIREMENTS OF LOCAL UTILITIES, MUNICIPALITIES, STATE OR FEDERAL LAWS AND REGULATIONS. PERFORM THE WORK IN ACCORDANCE WITH SUCH REQUIREMENTS AT NO ADDITIONAL COST TO THE OWNER.
- K. PROVIDE ALL LABOR, MATERIALS, TOOLS, EQUIPMENT, ETC, REQUIRED FOR COMPLETE AND FUNCTIONAL SYSTEM AS SPECIFIED AND INDICATED ON THE DRAWINGS.
- DURING CONSTRUCTION PROCEDURES, THE ENTIRE WORK AREA SHALL BE CLEAN OF ALL DUST, DIRT AND OTHER DEBRIS BEFORE APPLICATION OF ANY NEW MATERIALS.
- M. ALL VENTS FROM HORIZONTAL SOIL OR WASTE PIPE SHALL COME OFF TOP OR AT 45 DEGREE VERTICALLY FROM CENTER OF PIPE BEFORE OFFSETTING HORIZONTALLY TO RISER.
- ALL VENT TERMINATIONS SHALL BE COORDINATED WITH BUILDING OPENINGS, AIR INTAKES AND AIR EXHAUST OPENINGS. ADJUST VENT THROUGH ROOF LOCATIONS TO COMPLY WITH APPLICABLE CODE AND TO BE IN THE LEAST VISIBLE EXTERIOR VIEWPOINT.
- O. SUPPORT ALL NEW PIPING AND EQUIPMENT FROM STRUCTURE ABOVE AS REQUIRED. PLUMBING CONTRACTOR SHALL PROVIDE ALL SUPPLEMENTAL STEEL TO SPAN BETWEEN PRIMARY BUILDING STRUCTURAL MEMBERS. PLUMBING CONTRACTOR SHALL BE RESPONSIBLE FOR THE COMPLETE DESIGN OF SUPPLEMENTAL STEEL AND PIPE SUPPORTS, INCLUDING REACTION LOADS TO PRIMARY BUILDING STRUCTURAL MEMBERS.
- PLUMBING CONTRACTOR TO PROVIDE AND INSTALL NAIL PLATES WHERE PIPING PASSES THROUGH STUD(S) WITHIN 2" OF NAILING SURFACE TO PROTECT PIPE FROM NAILS OR DRYWALL SCREWS.
- PLUMBING CONTRACTOR SHALL INSTALL HOT WATER DISTRIBUTION LOOP AND BRANCH SUPPLY PIPING AS CLOSE AS POSSIBLE TO THE HOT WATER INLET SIDE OF POINT OF USE THERMOSTATIC MIXING VALVE, INCLUDING FIXTURES WITH INTEGRAL MIXING VALVES, SO THAT THERE IS NO MORE THAN 10 LINEAR FEET DISTANCE. THIS SHALL BE IN SINGLE FIXTURE APPLICATIONS. LAVATORY HOT WATER PIPING SHALL BE INSTALLED SO THAT THERE IS A MAXIMUM DISTANCE OF 2 FT FROM THE THERMOSTATIC MIXING VALVE TO THE HOT WATER DISTRIBUTION PIPING PER C404.5 OF THE 2015 IECC. IN MULTIPLE FIXTURE APPLICATIONS BATTERIED IN WALL OR PIPE CHASES, THE HOT WATER SUPPLY PIPING SHALL BE AS CLOSE AS REASONABLY POSSIBLE TO THE FIXTURE CONNECTIONS.
- R. ALL P-TRAPS FOR FLOOR DRAINS AND FLOOR SINKS SHALL BE DEEP SEAL TRAP FILLED WITH WATER. 2" TRAPS SHALL HAVE A 4" MINIMUM WATER SEAL. 3" AND LARGER SHALL HAVE A 5" WATER SEAL.
- S. PLUMBING CONTRACTOR TO INSTALL, TEST, AND FIELD BALANCE APPROVED EQUIPMENT PER MANUFACTURER'S WRITTEN INSTRUCTIONS AND RECOMMENDATIONS.



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ELEVEN MILE PHASE 1 BID SET

PROJECT NO.: 0180930.00 DRAWN: JB/CF REVIEWED: 09/12/18

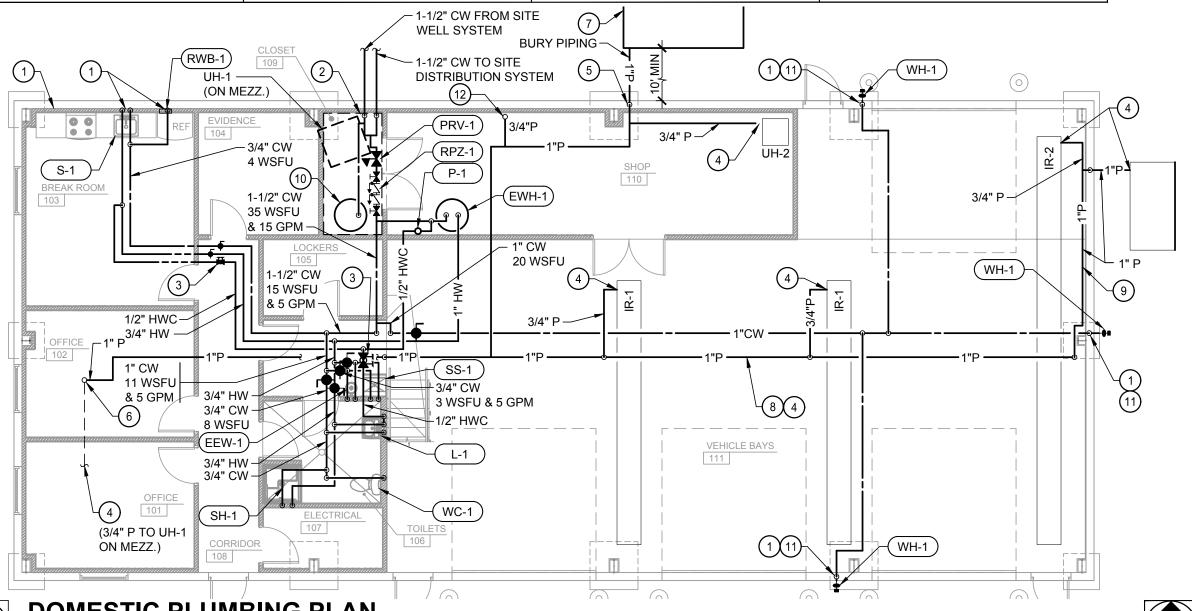
P0.2

KEYED NOTES

- ROUTE DOMESTIC PIPING ON INTERIOR SIDE OF INSULATION ON EXTERIOR WALL.
- REFER TO WATER ENTRY DIAGRAM FOR ADDITIONAL INFORMATION.
- SET CALIBRATED BALANCE VALVES TO APPROXIMATELY 0.5 GPM.
- CONNECT TO MECHANICAL EQUIPMENT HERE. REFER TO MECHANICAL PLANS FOR ADDITIONAL INFORMATION.
- WELD ALL PROPANE PIPING INTERNAL TO BUILDING. EXTERIOR PIPING MAY BE THREADED. PAINT EXTERIOR PIPING TO MATCH BUILDING EXTERIOR. PAINT EXPOSED INTERIOR PIPING TO MATCH CEILING IN EACH SPACE.
- 6. ROUTE PROPANE PIPING UP TO GAS FURNACE ON MEZZANINE LEVEL AND CONNECT.
- 7. PROVIDE MIN 1000GAL PROPANE TANK MIN 10 FT FROM BLDG EDGE. COORDINATE EXACT LOCATION REQUIREMENTS AND RECOMMENDED SIZE WITH PROPANE PROVIDER.
- ROUTE PROPANE PIPING TIGHT TO STRUCTURE IN OVERHEAD ABOVE THE INFRARED HEATERS. COORDINATE MECHANICAL EQUIPMENT HEATER CLEARANCES WITH MECHANICAL CONTRACTOR PRIOR TO PURCHASE AND INSTALLATION.
- ROUTE 1" PROPANE LINE TIGHT TO INTERIOR OF EXTERIOR WALL HERE.
- 10. REFER TO SHEET P5.2.
- 11. PROVIDE ISOLATION AND HIGH POINT VENT VALVES IN RISER TO ALLOW FOR WINTER DRAIN DOWN OF WALL HYDRANT.
- 12. 3/4"PROPANE TO UH-1 ON MEZZANINE.

GENERAL NOTES

- A. SANITARY WASTE PIPING SHALL BE SLOPED AT 1/8-INCH PER FOOT MINIMUM FOR ALL PIPING 4-INCH AND LARGER AND AT 1/4-INCH PER FOOT MINIMUM FOR ALL PIPING 3-INCH AND SMALLER.
- B. PLUMBING CONTRACTOR SHALL **INSTALL APPROVED WATER HAMMER** ARRESTORS IN WATER LINES, BOTH HOT AND COLD, SERVING BATTERY AND BACK TO BACK FIXTURE INSTALLATIONS IN PIPE SPACE AND PIPE CHASES AND SHALL BE ACCESSIBLE.
- C. SEAL ALL EXTERIOR WALL PENETRATIONS AIR AND WATER TIGHT.
- D. ROUTE ALL PIPING THROUGH STRUCTURAL ELEMENTS. COORDINATE PENETRATION SIZES AND LOCATIONS WITH STRUCTURAL. LOCATE ALL VALVES IN-BETWEEN JOISTS AND PROVIDE ACCESS PANELS FOR FULL VALVE ACCESSIBILITY. REFERENCE STRUCTURAL DRAWINGS.
- E. SEE PLUMBING FIXTURE SCHEDULE FOR PIPE SIZING TO INDIVIDUAL PLUMBING FIXTURES.
- F. INSULATE ALL DOMESTIC WATER PIPING PER TABLE C403.2.10 OF THE 2015 IECC. REFER TO SPECIFICATIONS FOR ADDITIONAL INSULATION REQUIREMENTS.



DOMESTIC PLUMBING PLAN

SCALE: 1/8" = 1'-0"

4755 FORGE ROAD, SUITE 150

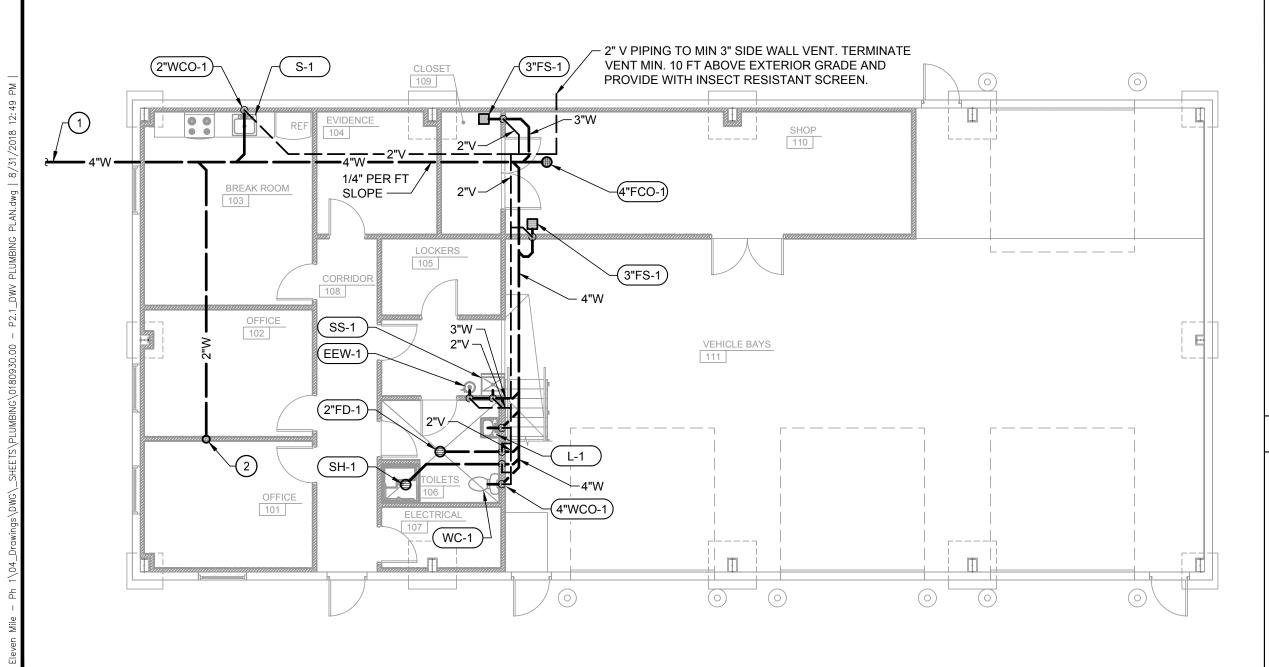
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GENERAL NOTES

- A. SANITARY WASTE PIPING SHALL BE SLOPED AT 1/8-INCH PER FOOT MINIMUM FOR ALL PIPING 4-INCH AND LARGER AND AT 1/4-INCH PER FOOT MINIMUM FOR ALL PIPING 3-INCH AND SMALLER.
- B. PLUMBING CONTRACTOR SHALL INSTALL APPROVED WATER HAMMER ARRESTORS IN WATER LINES, BOTH HOT AND COLD, SERVING BATTERY AND BACK TO BACK FIXTURE INSTALLATIONS IN PIPE SPACE AND PIPE CHASES AND SHALL BE ACCESSIBLE.
- C. SEAL ALL EXTERIOR WALL PENETRATIONS AIR AND WATER TIGHT.
- D. ROUTE ALL PIPING THROUGH STRUCTURAL ELEMENTS. COORDINATE PENETRATION SIZES AND LOCATIONS WITH STRUCTURAL. LOCATE ALL VALVES IN-BETWEEN JOISTS AND PROVIDE ACCESS PANELS FOR FULL VALVE ACCESSIBILITY. REFERENCE STRUCTURAL DRAWINGS.
- E. SEE PLUMBING FIXTURE SCHEDULE FOR PIPE SIZING TO INDIVIDUAL PLUMBING FIXTURES.
- F. REFER TO SPECIFICATIONS FOR ADDITIONAL INFORMATION AND INSTRUCTIONS.

GENERAL NOTES

- 1. 4" W APPROX. 30" B.F.F., ROUTED IN INSULATED TRENCH TO (E) SEPTIC. REFER TO SITE PLAN.
- 2. 2" W UP TO 2" FD IN THE MEZZANINE MECHANICAL EQUIPMENT ROOM FOR CONDENSATE. LOCATE FD FOR EASE OF MAINTENANCE ACCESS AND ADJACENT TO GAS FURNACE. 2" VENTING FROM FD IS TO BE ROUTED UNDER ROOF AND CONNECTED TO NEAREST MIN 2" V PIPING PRIOR TO ROOF PENETRATION.

DWV PLUMBING PLAN

SCALE: 1/8" = 1'-0"



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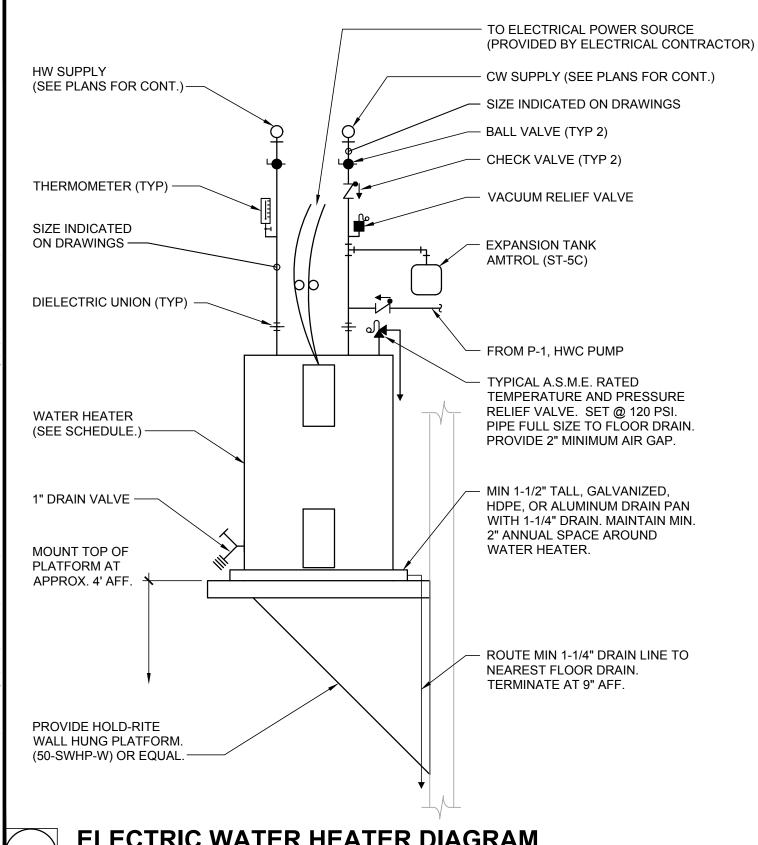
DWV PLUMBING PLAN

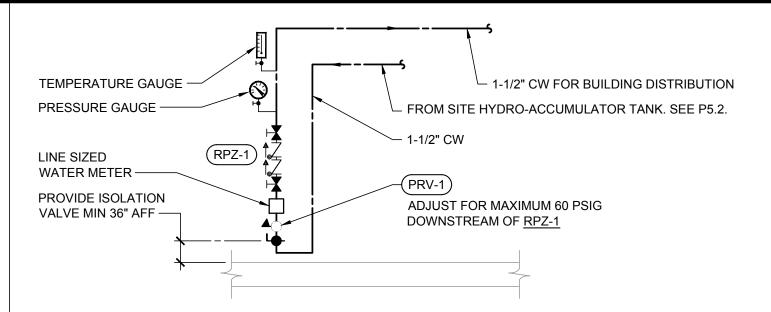
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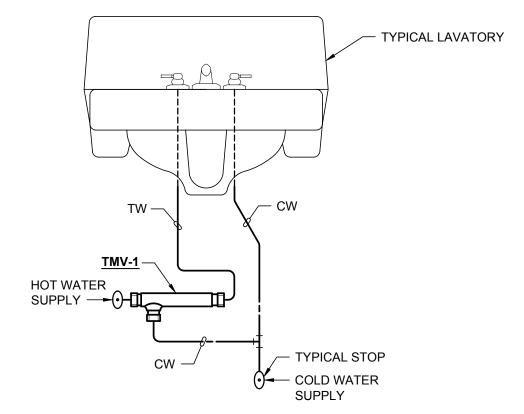
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WATER ENTRY DIAGRAM

SCALE: NO SCALE



ELECTRIC WATER HEATER DIAGRAM

SCALE: NO SCALE

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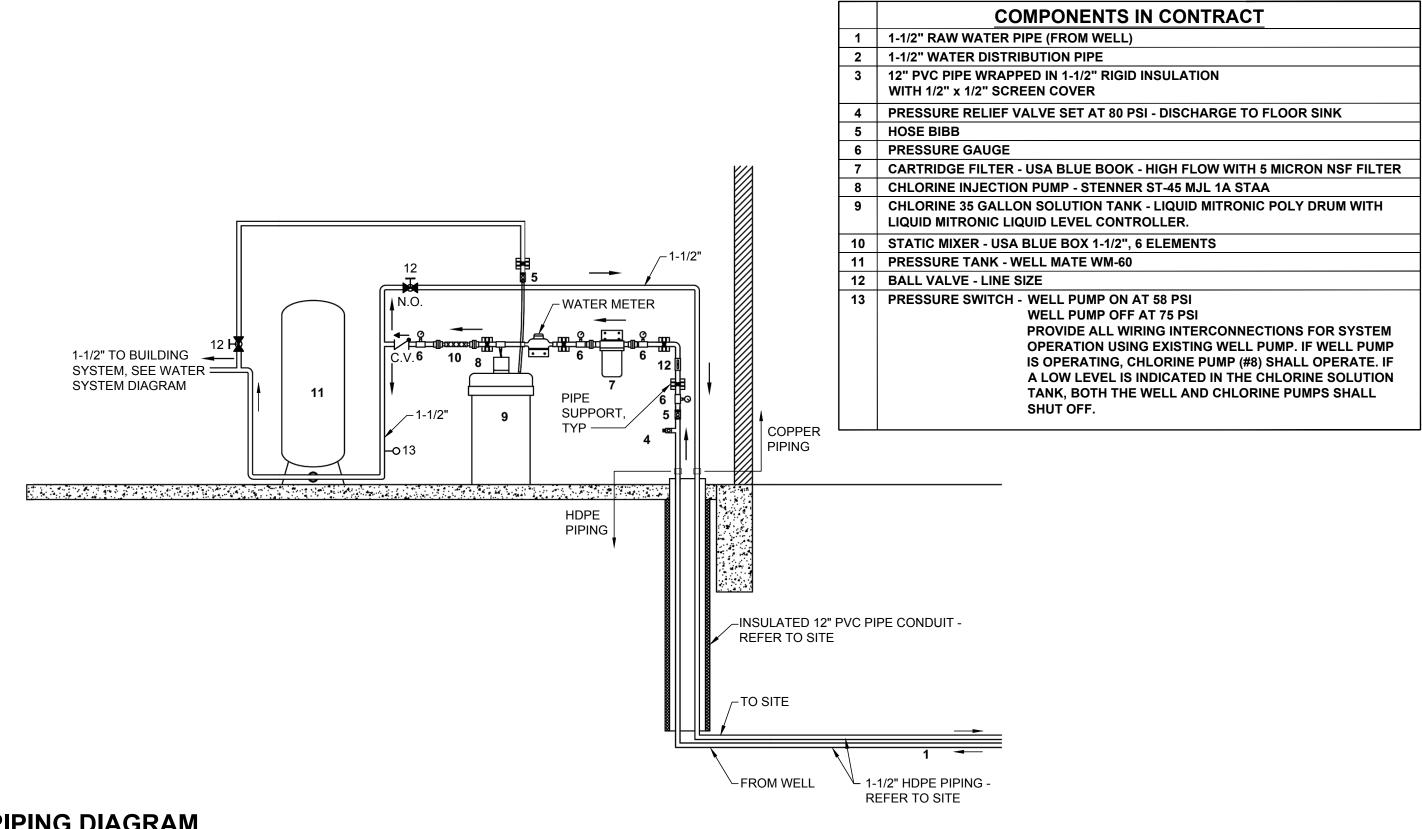
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LAVATORY TMV DIAGRAM SCALE: NO SCALE

PLUMBING DIAGRAMS



PIPING DIAGRAM

SCALE: NO SCALE



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ELEVEN MILE PHASE 1 BID SET

PLUMBING DIAGRAMS

PROJECT NO.: 0180930.00 JB/CF REVIEWED:

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DOMESTIC PUMP SCHEDULE ARRANGEMENT MANUFACTURER MODEL NOTES TAG SERVICE LOCATION **TYPE** FLUID **GPM** FT HD **RPM** HP VOLT/PH DOMESTIC HOT WATER CIRC | FIRST LVL JANITOR RM | DOMESTIC HOT WATER INLINE WATER 1.5 3250 1/40 115/1 TACO 003-SC4 1-3

NOTES: 1. ALL STAINLESS STEEL CONSTRUCTION

- 2. HORIZONTAL INLINE MOUNTED CIRC PUMP WITH 24/7 PROGRAMMABLE LINE VOLTAGE TIMECLOCK CONTROLLER.
- 3. COORDINATE TIME CLOCK OPERATION SETTINGS WITH OWNER.

ELECTRIC WATER HEATER SCHEDULE														
PLAN MARK	MANUFACTURER MODEL		STORAGE IN GALLONS	RECOVERY GPH @ 100 DEG.	KW INPUT	NUMBER OF ELEMENTS	VOLTS	PHASE FLA		HEIGHT DIAMTER (IN.)		OPERATING WEIGHT (LBS.)		REMARKS
EWH-1	AO SMITH	DSE-30	30	49	12.0	1	240	1	50	31.75	22	398	1-3	
NOTES:														

PLUMBING PIPING MATERIAL SCHEDULE										
SYSTEM TYPE	MATERIAL SELECTION									
DOM. CW ABOVE GRADE	TYPE L COPPER									
DOM. HW ABOVE GRADE	TYPE L COPPER									
DOM. HWC ABOVE GRADE	TYPE L COPPER									
SANITARY BELOW GRADE PIPING	CAST IRON, CISPI 301 HUBLESS OR HUB AND SPIGOT PIPING; OR ASTM D2665 SCHEDULE 40 PVC									
SANITARY ABOVE GRADE PIPING TO FIXTURES (NOT IN PLENUM SPACES)	CAST IRON, CISPI 301 HUBLESS OR HUB AND SPIGOT PIPING; OR ASTM D2665 SCHEDULE 40 PVC									
SANITARY VENT PIPING	CAST IRON PIPING OR PVC - NO PVC VENT PIPING ALLOWED IN RETURN AIR PLENUMS									

NOTES

PROVIDE ALL DOMESTIC WATER SYSTEMS WITH ASTM B88 (ASTM B88M) PIPING, ASME B16.18 OR ASME B16.22 PIPE FITTINGS, SOLDER AND FLUX (IF USED) THAT COMPLY WITH NSF 61 AND NSF 372 FOR MAXIMUM LEAD CONTENT FOR COPPER PIPING INSTALLATIONS.

PROVIDE ASTM D2564 SOLVENT FOR ANY PVC DRAIN PIPING.

IN ALL CASES REFER TO PLUMBING SPECIFICATIONS.

BUILDING GAS LOAD SCHEDULE											
INPUT											
(BTU/HR)											
60,000											
600,000											
150,000											
30,000											
60,000											
60,000											
125,000											
1,085,000											
8600	FT										
174	FT										
2	PSI										
1	PSI										
	INPUT (BTU/HR) 60,000 600,000 150,000 30,000 60,000 125,000 1,085,000 8600										



ELEVEN MILE PHASE 1 BID SET

PLUMBING FIXTURE SCHEDULE								PLUMBING FIXTURE SCHEDULE							
PLAN FUEL DE CONTROL AND DE LA			MINIMUM INDIVIDUAL LINE SIZES						MINIMUM INDIVIDUAL LINE SIZES						
MARK	FIXTURE DESCRIPTION AND REMARKS	COLD WATER	HOT WATER	WASTE	VENT	ELEC	PLAN MARK	FIXTURE DESCRIPTION AND REMARKS	COLD WATER	HOT WATER	WASTE	VENT	ELEC		
EEW-1	EMERGENCY EYE/FACE WASH: 304 STAINLESS STEEL BOWL WITH CLEAR PLASTIC DUST COVER. 304 STAINLESS STEEL EYE/FACE WASH SPRAYER AND YOKE, WITH GENTLE FLOW. PROVIDE WITH 304 STAINLESS STEEL PIPING AND 316 SS, STAY OPEN BALL VALVE WITH 316 STAINLESS STEEL ACTIVATION HANDLE. WATER MUST FLOW AT 3 GPM MIN FLOW RATE. AND DRAIN TO THE SANITARY SYSTEM. ACCEPTABLE MANUFACTURERS: BRADLEY (S192140B2FFB0P), SPEAKMAN, HAWS, CHICAGO FAUCET, WESTERN. ACCESSORIES: PROVIDE WITH AN ASSE 1071 RATED THERMOSTATIC MIXING VALVE SET TO 85°F FOR SCALD PROTECTION, PROVIDE WITH REFLECTIVE TAPE ON PIPING.	1"	1"	1-1/2" MIN	1-1/2" MIN	N/A	S-1	SINK- ADA, COUNTER MOUNTED, SELF-RIMMING, 18 GAUGE 304 STAINLESS STEEL, 25 INCH x 21 INCH x 6-1/2 INCH DEEP, SINGLE COMPARTMENT, UNDERCOATED WITH THREE HOLE DRILLINGS ON 4" CENTERS. ACCEPTABLE MANUFACTURERS: ELKAY (LRAD252165PD), JUST MFG. MOEN, AMERICAN STANDARD. SINK TRIM: MANUAL, SINGLE LEVER FAUCET WITH 8 INCH COVER PLATE AND PULL DOWN SPRAYER. 1.8 GPM FLOWRATE. PROVIDE WITH TMV-1 SET TO 120°F MAX OUT TEMP. ACCEPTABLE MANUFACTURERS: KOHLER (K-7305-5A),DELTA, MOEN, AMERICAN STANDARD. ACCESSORIES: PROVIDE DRAIN LINE WITH MIN. 17 GAUGE OFFSET GRID STRAINER AND TAILPIECE WITH MIN. 17 GAUGE P-TRAP WITH INTEGRAL CLEANOUT. PROVIDE WITH ADA TRAP,		1/2"	1-1/2"	1-1/2"	N/A		
FD-1	FLOOR DRAIN - DUCCO CAST IRON BODY WITH ROUND, POLISHED NICKEL-BRONZE FINISHED STRAINER, HEEL-PROOF GRATE, WITH ADJUSTABLE STRAINER HEAD. PROVIDE WITH TS-1. ACCEPTABLE MANUFACTURERS: JAY R. SMITH (2005) ZURN, WADE, OR JOSAM.	N/A	N/A	2"	1-1/4" MIN	N/A		STOP AND SUPPLY PROTECTORS IF UNDERCOUNTER PIPING IS EXPOSED. PROVIDE QUARTER TURN, SOLID BRASS, CHROME PLATED ANGLE STOPS WITH FLEXIBLE HOSE SUPPLIES AND CHROME PLATED WALL ESCUTCHEONS.							
FS-1	FLOOR SINK - 8 INCH DEEP, CAST IRON BODY AND 12X12 INCH SQUARE AREA, HEEL-PROOF. PROVIDE WITH A HALF GRATE UNLESS OTHERWISE NOTED ON DRAWINGS. PROVIDE WITH TS-1. ACCEPTABLE MANUFACTURERS: JOSAM (49340A-NB SERIES), WADE, ZURN, OR JAY R SMITH.	N/A	N/A	3"	1-1/2" MIN	N/A		SHOWER- WHITE, SMOOTH WALL, BARRIER FREE, L-SHAPED GRAB BAR, 3/4 INCH SKIRT, CENTER DRAIN AND GELCOATED SURFACE. ACCEPTABLE MANUFACTURERS: AQUATIC (1363BFSD) SHOWER VALVE: PRESSURE BALANCED MIXING VALVE SHALL BE FLUSH MOUNTED WITH							
L1	LAVATORY- WALL HUNG, WHITE, VITREOUS CHINA, 20 INCH x 18 INCH, WITH 4 INCH CENTERS, CONCEALED ARM SUPPORTS, 4 INCH BACKSPLASH AND OVERFLOW MOUNTED AT ADA REQUIRED HEIGHT. ACCEPTABLE MANUFACTURERS: AMERICAN STANDARD (0355.012), KOHLER, ZURN, ELJER, CRANE, GERBER, TOTO. LAVATORY TRIM: MANUAL, SINGLE LEVER VALVE FAUCET. BRASS CONSTRUCTION, WITH CHROME PLATED FINISH, AND 0.5 GPM, VANDAL RESISTANT AERATOR. PROVIDE WITH TMV-1 AND SET MAX OUTLET TEMPERATURE AT 105°F.	1/2"	1/2"	1-1/4"	1-1/2"	N/A	SH-1	CONCEALED PIPING AT ADA REQUIRED HEIGHT, SINGLE LEVER HANDLE AND INTEGRAL SCREWDRIVER STOPS. SET LIMIT STOPS AT 110°F, 2.5 GPM FLOW CONTROL, WITH COMBINATION SLIDE AND GRAB BAR. ACCEPTABLE MANUFACTURERS: AQUATIC (PART OF ADA PACKAGE), DELTA, AMERICAN STANDARD, SYMMONS, SPEAKMAN, LEONARD, POWERS. SHOWER TRIM: PROVIDE WITH SOAP DISH, BRASS DRAIN AND ADA COMPLIANT SHOWER CURTAIN. PROVIDE ADA SEAT IN LEFT HAND OR RIGHT HAND CONFIGURATION AS INDICATED ON DRAWINGS.	1/2"	1/2"	2"	2"	N/A		
	ACCEPTABLE MANUFACTURERS: ZURN (Z6955-XL-S-F-LL), DELTA , T&S BRASS, SPEAKMAN, CHICAGO FAUCET. ACCESSORIES: PROVIDE DRAIN LINE WITH MIN. 17 GAUGE OFFSET GRID STRAINER AND TAILPIECE WITH MIN. 17 GAUGE P-TRAP WITH INTEGRAL CLEANOUT. PROVIDE WITH ADA TRAP, STOP AND SUPPLY PROTECTORS IF UNDERCOUNTER PIPING IS EXPOSED. PROVIDE QUARTER TURN, SOLID BRASS, CHROME PLATED ANGLE STOPS WITH FLEXIBLE HOSE SUPPLIES AND CHROME PLATED WALL ESCUTCHEONS.	1/2	1/2	1-1/4	1-1/2	IVA	SS-1	SERVICE SINK- FLOOR MOUNTED ON 18 GAUGE, STAINLESS STEEL LEGS. PROVIDE WITH 18 GAUGE STAINLESS STEEL BASIN, 20 INCH x 16 INCH x 8 INCH DEEP. PROVIDE REINFORCING IN WALL FOR MOUNTING FAUCET SUPPORT BRACKET. ACCEPTABLE MANUFACTURERS: FLORESTONE ADVANCE TABCO (8-OP-16). MOP SERVICE BASIN TRIM: CHROME PLATED CAST BRASS VACUUM BREAKER SPOUT, 3/4 INCHOSE THREADED OUTLET, PAIL HOOK WITH WALL SUPPORT, INTEGRAL SCREWDRIVER STOP WITH COVERING CAPS, STRAIGHT SHANK WITH FLANGE AND CROSS TYPE HANDLES. PROVID WITH TMV-1 AND SET MAX OUTLET TEMPERATURE AT 120°F.	1/2"	1/2"	3"	1-1/2"	N/A		
PRV-1	PRESSURE REGULATING VALVE- LEAD FREE, PROVIDE WITH PRESSURE AND TEMPERATURE GAUGES AT OUTLET. ACCEPTABLE MANUFACTURERS: WATTS (LF25AUB-Z3), ZURN, BELL AND GOSSETT	1-1/2"	N/A	N/A	N/A	N/A		ACCEPTABLE MANUFACTURERS: DELTA (28T9) ACCESSORIES: PROVIDE WITH 5 FEET OF 1/2 INCH PLAIN END REINFORCED RUBBER HOSE, HOSE CLAMP AND ADJACENT MOP HANGER.							
RPZ-1	REDUCED PRESSURE BACKFLOW PREVENTER - BRONZE SEATS AND STAINLESS STEEL TRIM. THE ASSEMBLY SHALL INCLUDE QUARTER TURN SHUT-OFF VALVES, TEST COCKS, AND WYE STRAINER. ACCEPTABLE MANUFACTURERS: WATTS (LF909QT).	1-1/2"	N/A	N/A	N/A	N/A	TMV-1	THERMOSTATIC MIXING VALVE- LEAD FREE CONSTRUCTION, FOR SINGLE FIXTURE APPLICATION, ALLOWING DOWN TO 0.25 GPM. WITH INTEGRAL CHECK VALVES AND FILTER SCREEN. ACCEPTABLE MANUFACTURERS: WATTS (MODEL LFUSG-B) OR EQUIVALENT.	3/8"	3/8"	N/A	N/A	N/A		
	RECESSED WALL BOX - 5 INCH x 6 INCH BOX CONSTRUCTED OF GALVANIZED STEEL WITH WHITE POWDER COAT FINISH. PROVIDE WITH QUARTER TURN, LOW LEAD COLD WATER SUPPLY CONNECTION AND INTEGRAL WATER HAMMER ARRESTOR.						TS-1	TRAP SEAL - ELASTOMERIC MATERIAL WITH TORTUROUS PATH. ASSE 1072 COMPLIANT. ACCEPTABLE MANUFACTURERS: SURE SEAL (SS2009V.)	N/A	N/A	SEE DWGS	N/A	N/A		
RWB-1	ACCEPTABLE MANUFACTURERS: OATEY (39140), GUY GRAY, PPP OR EQUAL. ACCESSORIES: VERIFY EQUIPMENT LOCATION AND ROUGH IN REQUIREMENTS. MOUNT IN ACCORDANCE WITH MANUFACTURER'S WRITTEN INSTRUCTIONS.	WATER CLOSET- ADA, FLOOR MOUNTED WITH 12 INCH ROUGH-IN, PRESSURE ASSISTED FLUSI TANK. PROVIDE WITH WHITE, VITREOUS CHINA, AND ELONGATED BOWL. UNIT SHALL FLUSH ON 1.0 GALLON OF WATER PER FLUSH AND MUST BE EPA WATER SENSE CERTIFIED WITH A MAP SCORE OF 1000 OR GREATER. WC-1 WC-1 WC-1 WC-1 WC-1 WC-1 WC-1 WC-1 WATER CLOSET- ADA, FLOOR MOUNTED WITH 12 INCH ROUGH-IN, PRESSURE ASSISTED FLUSH TANK. PROVIDE WITH WHITE, VITREOUS CHINA, AND ELONGATED BOWL. UNIT SHALL FLUSH ON 1.0 GALLON OF WATER PER FLUSH AND MUST BE EPA WATER SENSE CERTIFIED WITH A MAP SCORE OF 1000 OR GREATER. APPROVED MANUFACTURERS: KOHLER (HIGHLINE, K-3519), AMERICAN STANDARD, ELJER, ZURN, CRANE, GERBER, TOTO. ACCESSORIES: PROVIDE WITH WHITE, OPEN FRONT SEAT LESS COVER WITH SELF SUSTAINING CHECK HINGES. COORDINATE VERTICALLY ADJUSTABLE CARRIER					1-1/2"	N/A	3"	2"	N/A				
							WCO-1	INSTALLATIONS WITH WALL THICKNESS PRIOR TO INSTALL. (ZURN, ZN1209-N4) WALL CLEAN OUT - DUCO CAST IRON CLEANOUT TEE WITH GAS AND WATER TIGHT BRONZE PLUG, SMOOTH STAINLESS STEEL ACCESS COVER AND VANDAL PROOF SCREW. APPROVED MANUFACTURERS: JAY R. SMITH (4510), ZURN	N/A	N/A	SEE DWGS	SEE DWGS	N/A		
							WH-1	WALL HYDRANT - CONCEALED, FREEZEPROOF WALL HYDRANT WITH HOSE CONNECTION AND BACKFLOW PREVENTER. ACCEPTABLE MANUFACTURERS: WOODFORD (B67)	3/4"	N/A	N/A	N/A	N/A		



ELEVEN MILE PHASE 1 BID SET PROJECT NO.: 0180930.00
DRAWN: SH
REVIEWED: JB/CF
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